LOCATION MAP NOT TO SCALE

CONSTRUCTION DRAWINGS for


BLANCHARD DIVISION 7050 MASONBORO SOUND ROAD

LOCATED IN CITY OF WILMINGTON NEW HANOVER COUNTY, NORTH CAROLINA


GENERAL NOTES: NEW HANOVER COUNTY PARCEL NUMBERS.: PORTION PID = R06700-005-018-000. TOTAL PROJECT AREA: 50,898 SF (1.16 AC.) . EXISTING ZONING DISTRICT: R-15 LAND CLASSIFICATION: RESIDENTIAL THIS SITE IS LOCATED IN ZONE X ACCORDING TO THE FEDERA EMERGENCY MANAGEMENT AGENCY'S FLOOD INSURANCE RATE MAP, COMMUNITY-PANEL NUMBER 3720314500J. DATED: 4/3/06. . EXISTING SITE ADDRESS: 7050 MASONBORO SOUND ROAD EXISTING IMPERVIOUS ONSITE = 17,750 SF . BOUNDARY, TREE AND TOPOGRAPHIC SURVEY PERFORMED AND PROVIDED TO CSD ENGINEERING BY MARK A STOCKS, PA SURVEYING. VERTICAL DATUM = BASED ON ASBUILTS FROM CFPUA FOR SSMH 1 . STORMWATER DRAINS TO HEWLETTS CREEK, SA;HQW 18-87-26 10. CAMA LANDUSE: WATERSHED RESOURCE PROTECTION AREA. 1. LAND OWNER — BLANCHARD BUILDING & PROPERTIES, INC WILMINGTON, NC 28409

WATER & SEWER USAGE NOTES:

CURRENT WATER USAGE 360 GPD PROPOSED WATER USAGE 1,440 GPD CURRENT SEWER USAGE 360 GPD PROPOSED SEWER USAGE 1,440 GPD 12 BEDROOMS X 120 GPD = 1,440 GPD

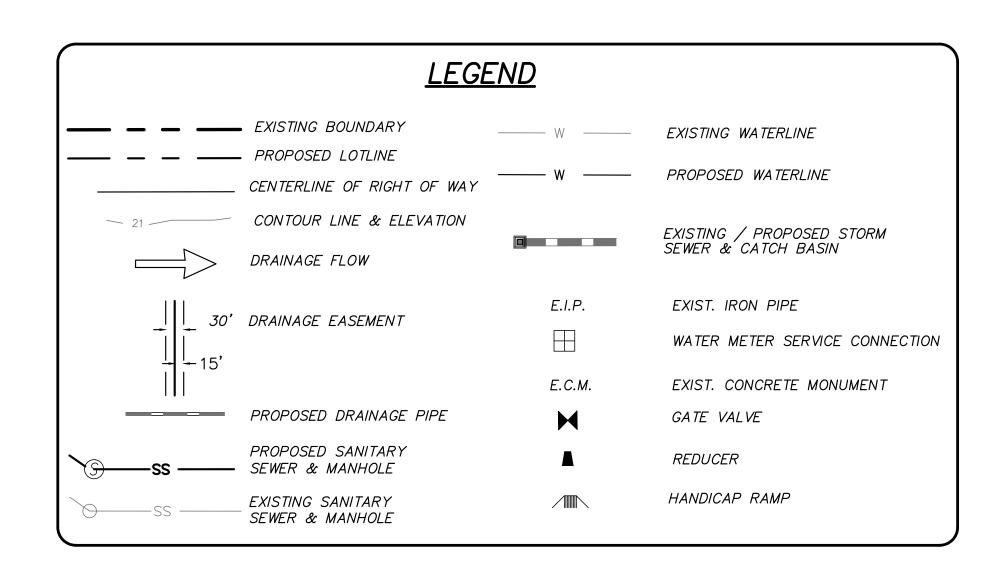

OWNER: BLANCHARD BUILDING AND PROPERTIES, INC. 111 MONTEREY DRIVE WILMINGTON, NC 28409

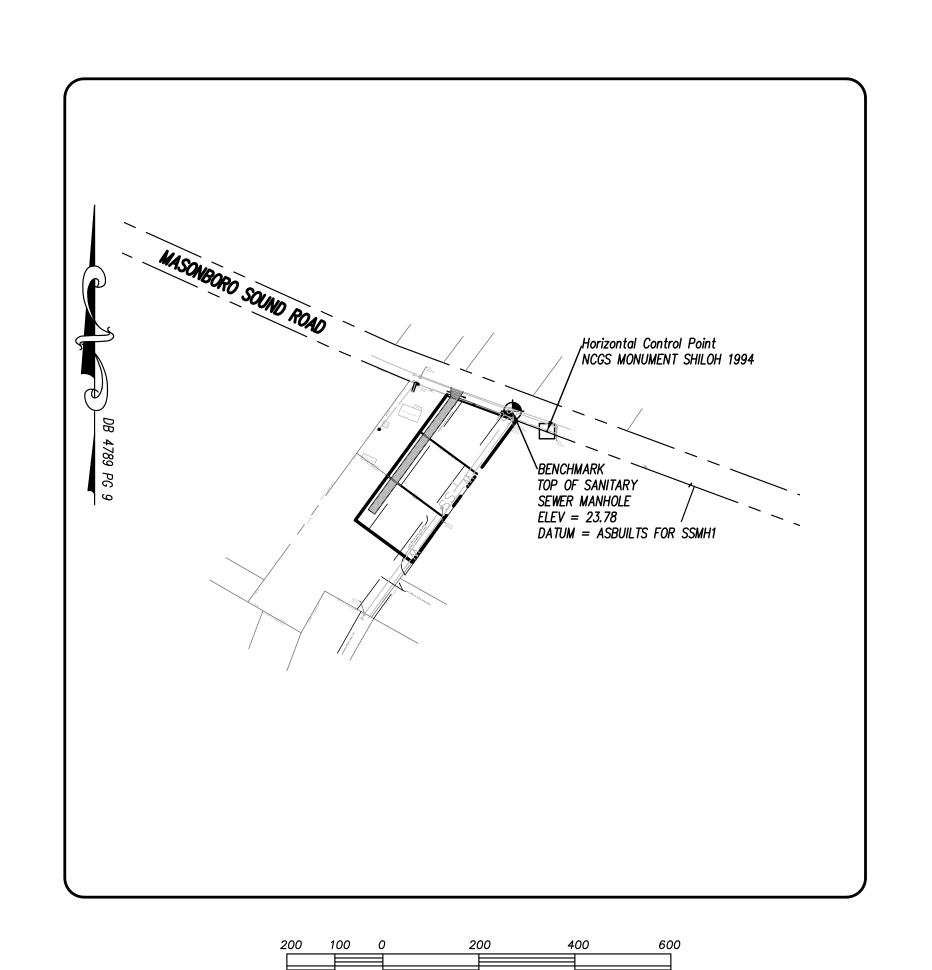

SCALE IN FEET: 1"= 200'

SHEET No.	DESCRIPTION	DRAWING No
1 OF 6	COVER SHEET	CD_COVER
2 OF 6	EX. CONDITIONS, DRAINAGE AND UTILITY PLAN	SP1
3 OF 6	SITE PLAN	SP1
4 OF 6	CITY OF WILMINGTON DETAILS	COW_DET-1
5 OF 6	CFPUA STANDARD WATER DETAILS	WSD-1
6 OF 6	CFPUA STANDARD SEWER DETAILS	SSD-1

Approv	ved Construction Plan
Name	Date
Planning	
Traffic	
Fire	



- 1. ASBUILT, BOUNDARY AND TOPOGRAPHIC SURVEY PERFORMED AND PROVIDED TO CSD ENGINEERING BY MARK A STOCKS, PA SURVEYING. VERTICAL DATUM = BASED ON ASBUILTS FROM CFPUA FOR SSMH 1 2. THIS MAP IS NOT FOR CONVEYANCE, RECORDATION, OR SALES.
- 3. THIS PROPERTY IS LOCATED WITHIN ZONE "X" ACCORDING TO THE FEDERAL EMERGENCY MANAGEMENT AGENCY'S FLOOD INSURANCE RATE MAP, COMMUNITY-PANEL #3720314500J, EFFECTIVE DATE 4/3/06
- 4. THIS PROPERTY IS ZONED R-15
- 5. CFPUA WATER
- 6. CFPUA SEWER
- 7. ALL CONSTRUCTION TO CONFORM TO NEW HANOVER COUNTY STANDARDS AND APPLICABLE STATE & LOCAL CODES.
- 8. CONTRACTOR TO COORDINATE ANY REQUIRED TRAFFIC CONTROL WITH CITY OF WILMINGTON AND OR NCDOT.
- 9. CARE SHALL BE TAKEN DURING FINAL GRADING TO ENSURE POSITIVE DRAINAGE AWAY FROM BUILDINGS AND TO RECEIVING STRUCTURES. ROOF DRAIN DOWNSPOUTS TO BE CONNECTED TO STORM DRAINAGE
- STUBOUTS OR DIRECTED TO STREET/PARKING AREAS. 10. CONTRACTOR IS RESPONSIBLE FOR COORDINATION OF ANY RELOCATIONS, RE-ALIGNMENTS, DISCONNECTIONS OR CONNECTIONS OF EXISTING UTILITIES WITH APPLICABLE AUTHORITIES.
- 11. CLEARING AND GRUBBING OF SITE TO INCLUDE REMOVAL OF EXISTING CURB, ASPHALT, INLETS, AND ANY OTHER STRUCTURES INCLUDING TREES, STUMPS AND DEBRIS EXISTING ON SITE. TREES NOT REQUIRED TO BE CLEARED FOR CONSTRUCTION SHALL REMAIN UNLESS OTHERWISE DIRECTED
- 12. INFORMATION CONCERNING UNDERGROUND UTILITIES WAS OBTAINED FROM AVAILABLE RECORDS. IT SHALL BE THE RESPONSIBILITY OF THE CONTRACTOR TO DETERMINE THE EXACT ELEVATIONS AND LOCATIONS OF ALL EXISTING UTILITIES AT ALL CROSSINGS PRIOR TO COMMENCING TRENCH EXCAVATION. IF ACTUAL CLEARANCES ARE LESS THAN INDICATED ON PLAN, THE CONTRACTOR SHALL CONTACT THE DESIGN ENGINEER BEFORE PROCEEDING WITH CONSTRUCTION. ANY CONDITION DISCOVERED OR EXISTING THAT WOULD NECESSITATE A MODIFICATION OF THESE PLANS SHALL BE BROUGHT TO THE ATTENTION OF THE DESIGN ENGINEER BEFORE PROCEEDING
- 13. NO CONSTRUCTION IS TO BEGIN BEFORE LOCATION OF EXISTING UTILITIES HAS BEEN DETERMINED. CALL "NC ONE—CALL" AT LEAST 48 HOURS BEFORE COMMENCING CONSTRUCTION.
- 14. CONTRACTOR SHALL ADJUST ALL MANHOLES, VALVE & CURB BOXES TO FINAL GRADE UPON COMPLETION OF ALL CONSTRUCTION. ANY BOXES DAMAGED OR OTHERWISE DISTURBED BY THE CONTRACTOR SHALL BE REPAIRED AT THE EXPENSE OF THE CONTRACTOR.
- 15. THE CONTRACTOR IS RESPONSIBLE FOR CONTROLLING DUST AND EROSION DURING CONSTRUCTION AT HIS EXPENSE. PARKING AREAS SHALL BE WATERED TO CONTROL DUST WHEN ORDERED BY THE ENGINEER.
- 16. NO GEOTECHNICAL TESTING HAS BEEN PERFORMED ON SITE. NO WARRANTY IS MADE FOR SUITABILITY OF SUBGRADE, AND UNDERCUT AND ANY REQUIRED REPLACEMENT WITH SUITABLE MATERIAL SHALL BE THE RESPONSIBILITY OF THE CONTRACTOR.
- 17. CONTRACTOR TO ENSURE THAT PAVEMENT IS PLACED SO AS TO DRAIN POSITIVELY TO THE STREET INLETS AND CATCH BASINS. ALL FUTURE ROOF DRAIN DOWNSPOUTS TO BE DIRECTED TO THE STORM DRAINAGE STUBOUTS.
- 18. CONTRACTOR IS RESPONSIBLE FOR OBTAINING ALL REQUIRED PERMITS. 19. THIS PLAN IS FOR SITE GRADING, UTILITIES, SITING, AND DRAINAGE ONLY.
- SEE BUILDING PLANS FOR DETAILED HOOKUPS TO BUILDINGS, ETC. 20. CONTRACTOR AND BUILDER ARE RESPONSIBLE FOR COORDINATING FINISHED FLOOR ELEVATION OF ALL BUILDINGS WITH THE OWNER. ELEVATIONS GIVEN ARE MINIMUM GROUND ELEVATIONS AT THE BUILDING SITE AND DO NOT
- PURPORT TO BE FINISHED FLOOR. MINIMUM RECOMMENDED FF ELEVATIONS SHOWN ON PLANS. 21. AFFECTED NON-MUNICIPAL UTILITIES SHALL BE CONTACTED AND PROVIDED WITH PLANS AND OTHER PERTINENT INFORMATION, WHEN FEASIBLE, TO
- COORDINATE APPROPRIATE SCHEDULING AND PLACEMENT. 22. EXTREME CARE SHALL BE TAKEN TO ENSURE MINIMUM SEPARATIONS
- AT ALL UTILITY CROSSINGS. 23. MINIMUM SEPARATION SHALL BE MAINTAINED AS FOLLOWS:
- a. HORIZONTAL SEPARATION OF 10 FEET BETWEEN SANITARY SEWER AND WATER MAINS AND STORM SEWER.
- b. WHERE VERTICAL CLEARANCE IS LESS THAN 24" BETWEEN SANITARY SEWER AND WATER OR WHERE SEWER LINE CROSSES ABOVE WATER MAIN, BOTH PIPES SHALL BE DUCTILE IRON PIPE FOR A MINIMUM OF 10' EITHER SIDE OF CROSSING.
- c. WHERE VERTICAL CLEARANCE IS LESS THAN 24" BETWEEN SANITARY SEWER AND STORM DRAIN, SANITARY SEWER SHALL BE DUCTILE IRON PIPE FOR A MINIMUM OF 10 FEET EITHER SIDE OF CROSSING.
- d. WHERE VERTICAL CLEARANCE IS LESS THAN 12" BETWEEN SANITARY SEWER AND STORM DRAIN, SANITARY SEWER SHALL BE DUCTILE IRON PIPE FOR A MINIMUM OF 10' EITHER SIDE OF CROSSING. AND BRIDGING SHALL BE INSTALLED PER APPLICABLE UTILITY AUTHORITY'S DETAILS.
- e. IN NO CASE SHALL THERE BE LESS THAN 18" OF SEPARATION BETWEEN OUTSIDE OF WATER MAIN AND OUTSIDE OF SEWER OR STORM DRAINAGE.
- f. MINIMUM COVER OF 36" SHALL BE PROVIDED FOR ALL BURIED WATER MAINS AND SANITARY SEWER MAINS.
- 24. SEE DETAIL SHEETS FOR TYPICAL UTILITIES HOOKUPS.
- 25. ALL SANITARY SEWER MAINS TO BE 8" UNLESS OTHERWISE INDICATED.
- 26. ALL WATER MAINS TO BE 8" UNLESS OTHERWISE INDICATED.
- 27. TWO VALVES ARE REQUIRED AT "T" INTERSECTIONS AND ONE VALVE ON THE WATER LINE TO FIRE HYDRANTS.
- 28. A BLOW-OFF VALVE IS REQUIRED AT THE TERMINUS OF ALL "DEAD END" WATER LINES.

ENGINEERING

LICENSE # C-2710 ENGINEERING LAND PLANNING COMMERCIAL / RESIDENTIAL

P.O. BOX 4041 WILMINGTON, NC 28406 (910) 791–4441




					D'
					$BY \mid D$
					REMARKS
					NO.
					REV. NO.
	 		7.	 	


DATE: 1-31-17


HORZ. SCALE: 1" = 200' VERT. SCALE: N/A DRAWN BY: MRB

> CHECKED BY: HSR PROJECT NO.: 16-0370

Sheet No. _____ Of ____

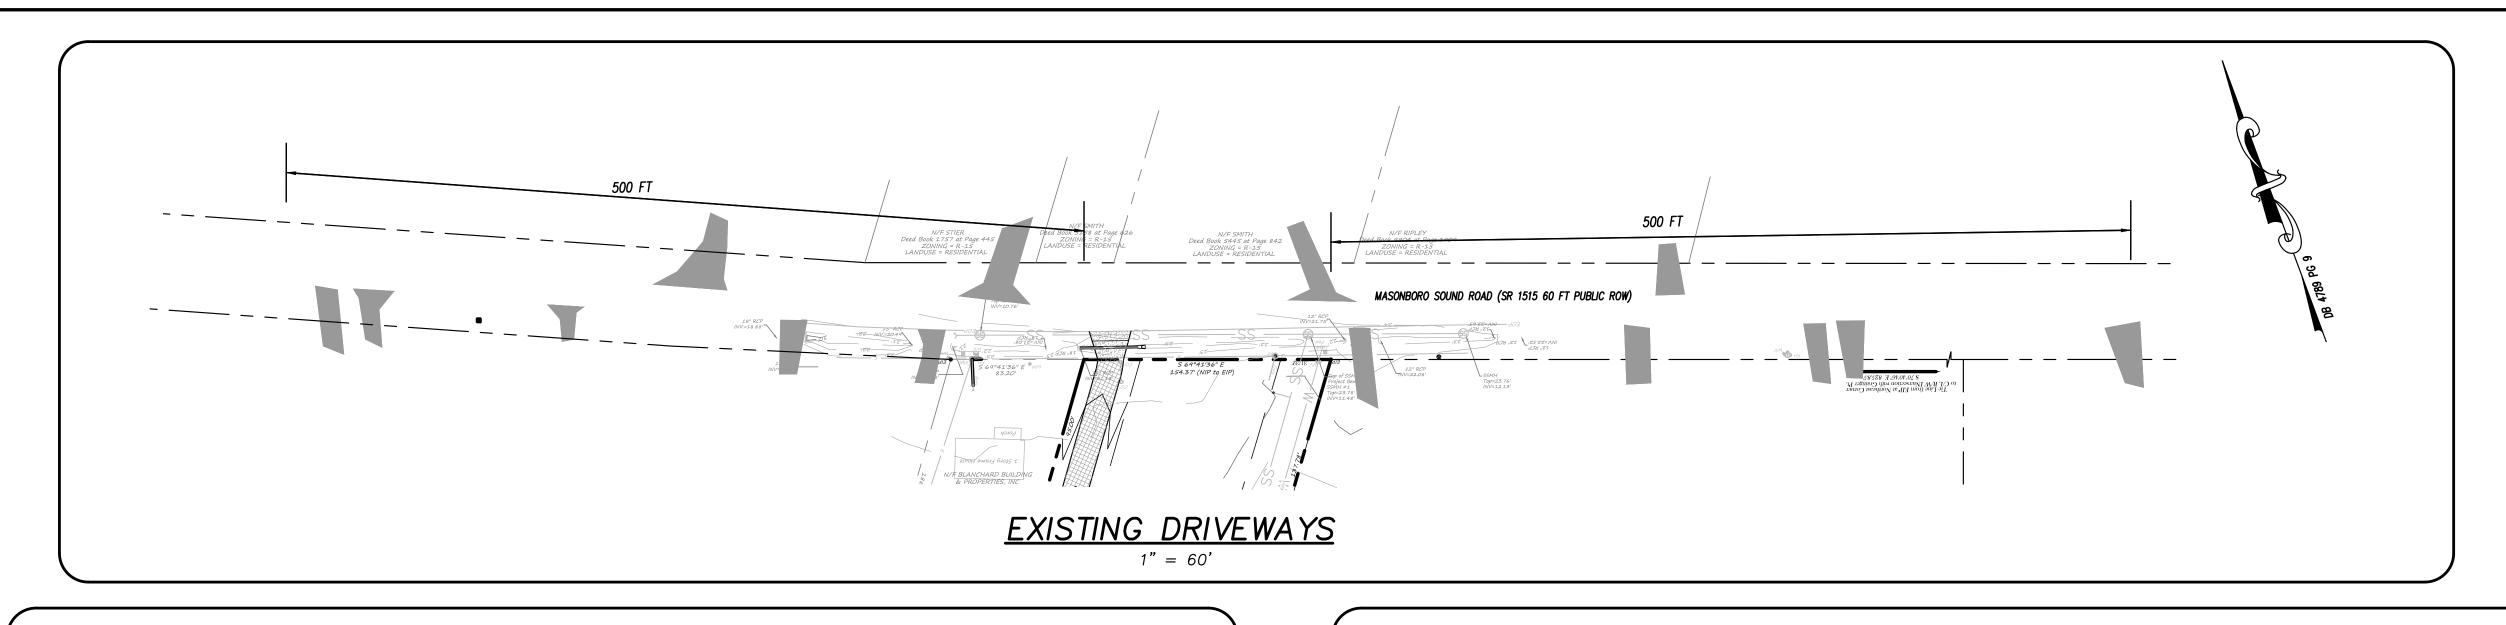

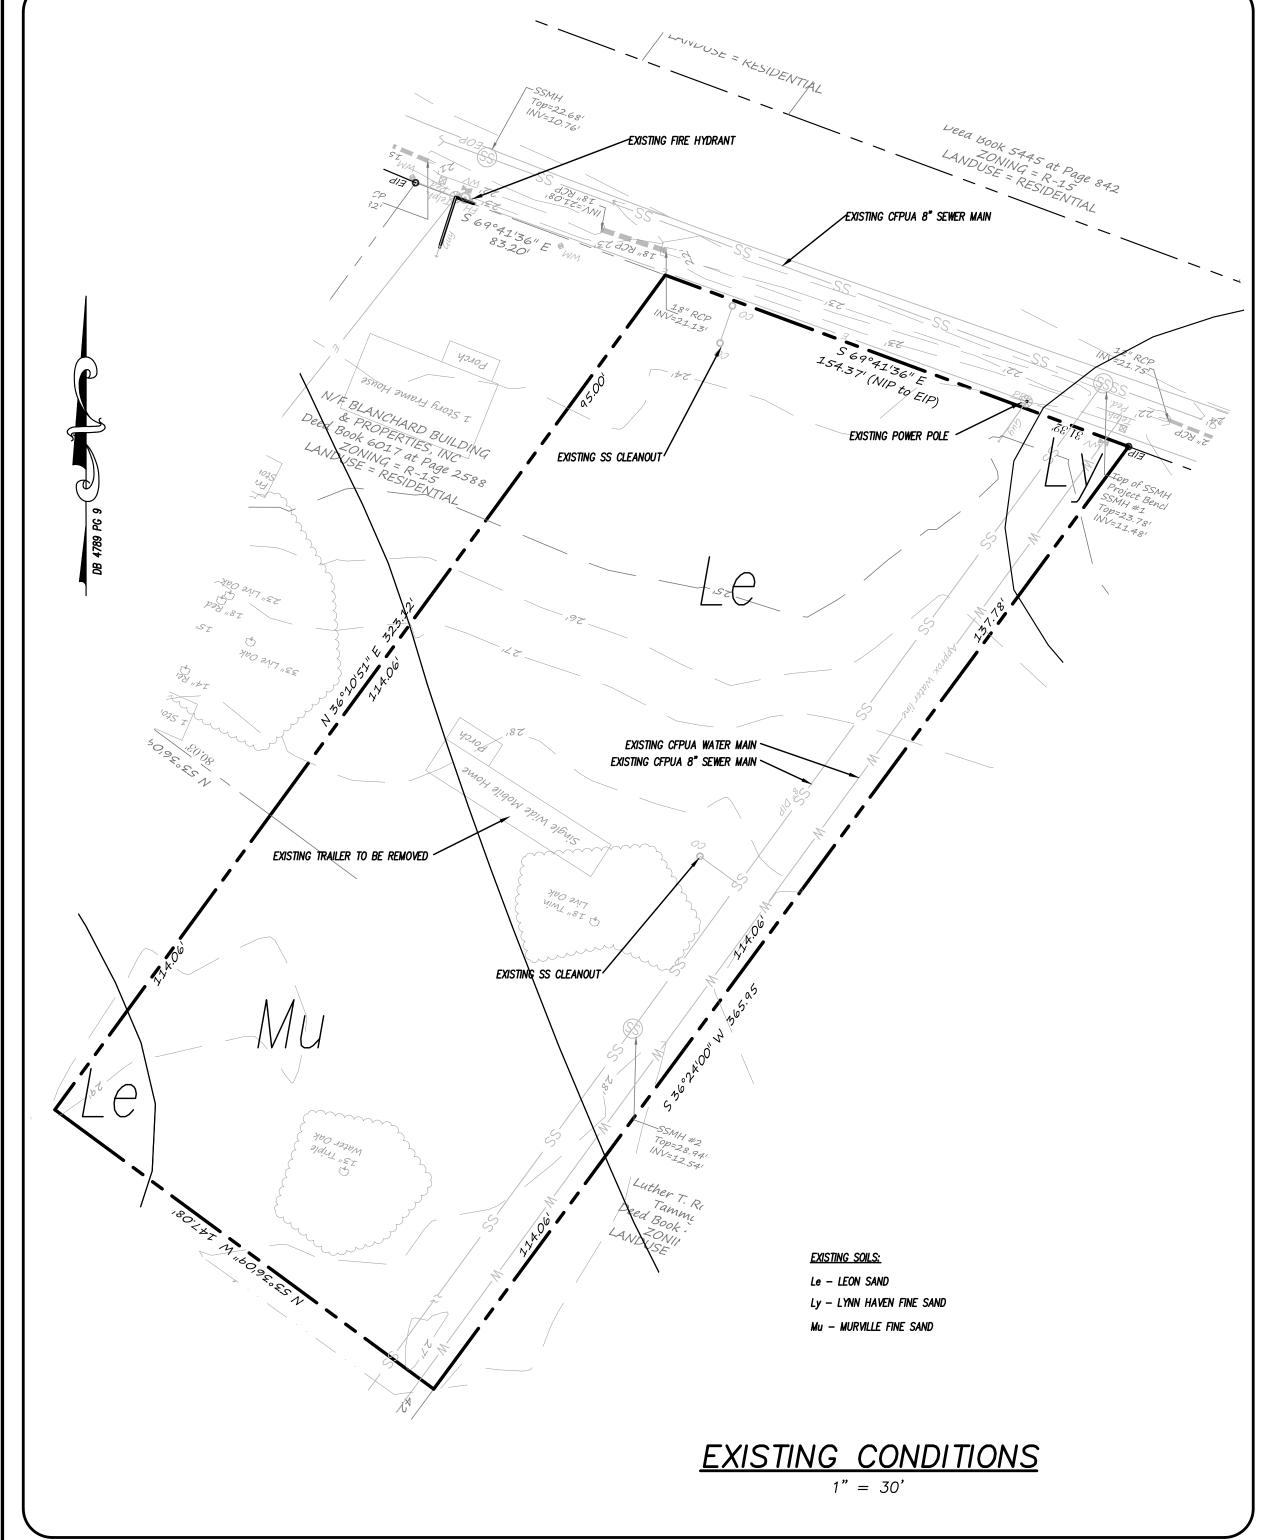

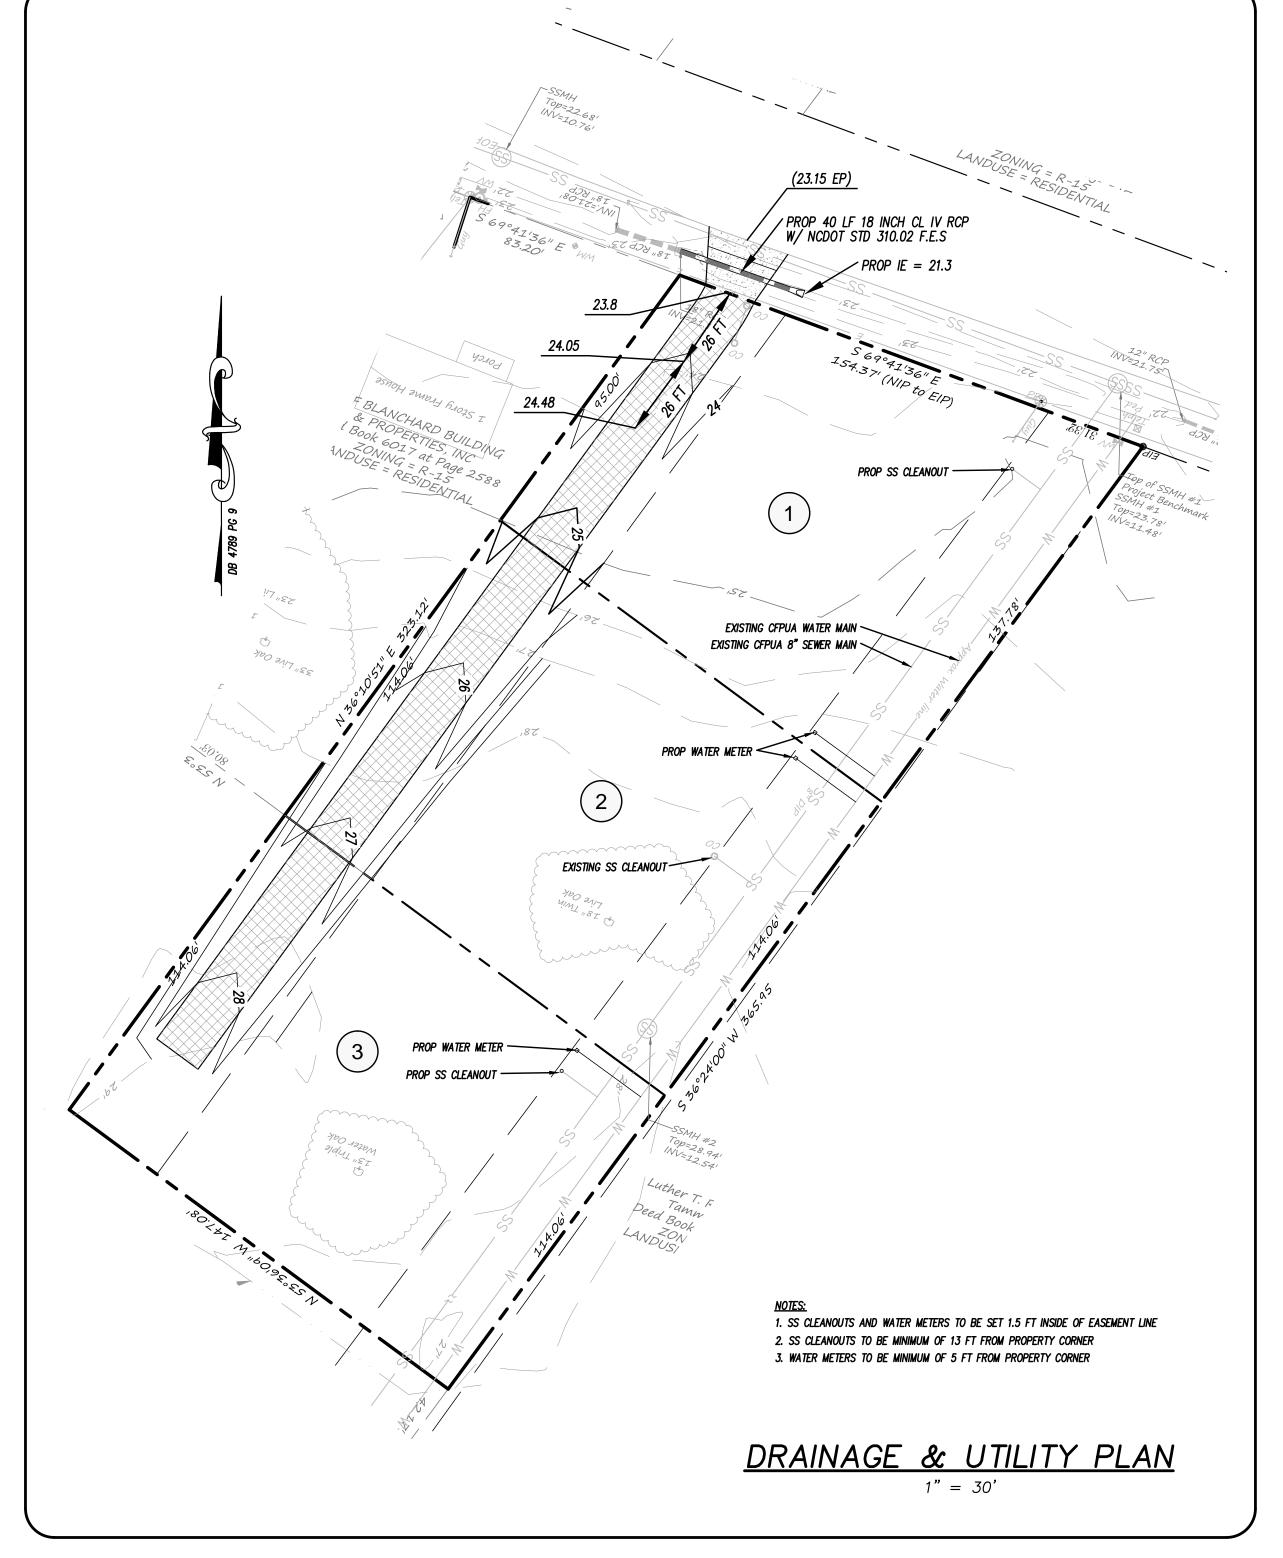



LICENSE # C-2710
ENGINEERING
LAND PLANNING
COMMERCIAL / RESIDENTIAL

P.O. BOX 4041 WILMINGTON, NC 28406 (910) 791–4441

AND UTILITY PLAN FOR
BLANCHARD DIVISION

EX. CONDITION, DRAINAGE AND UTILITY PLAN


BLANCHARD DIVISION

LOCATED IN CITY OF WILMINGTON

NEW HANOVER COUNTY, NORTH CAROLINA

OWNER:

BLANCHARD BUILDING AND PROPERTIES, INC.
111 MONTEREY DRIVE
WILMINGTON, NC 28409

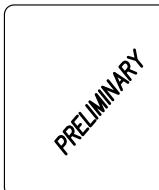

								ВҮ
								REMARKS
								REV. NO.
) <i>A</i> 7	E:	1	1—3	31-	-17	,	
H VI	ORZ ERT.	. <i>S</i> (CALE	: 1' :: ^	,	<i>30'</i>		

DRAWN BY: RLW


CHECKED BY: HSR


PROJECT NO.: 17-0394


Public Services Engineering Division
APPROVED PLAN — NO PERMIT REQUIRED
Signed:


	Approved Construc	tion Plan
	Name	Date
Planning		
Traffic		
Fire		


SCALE IN FEET: 1"= 30'

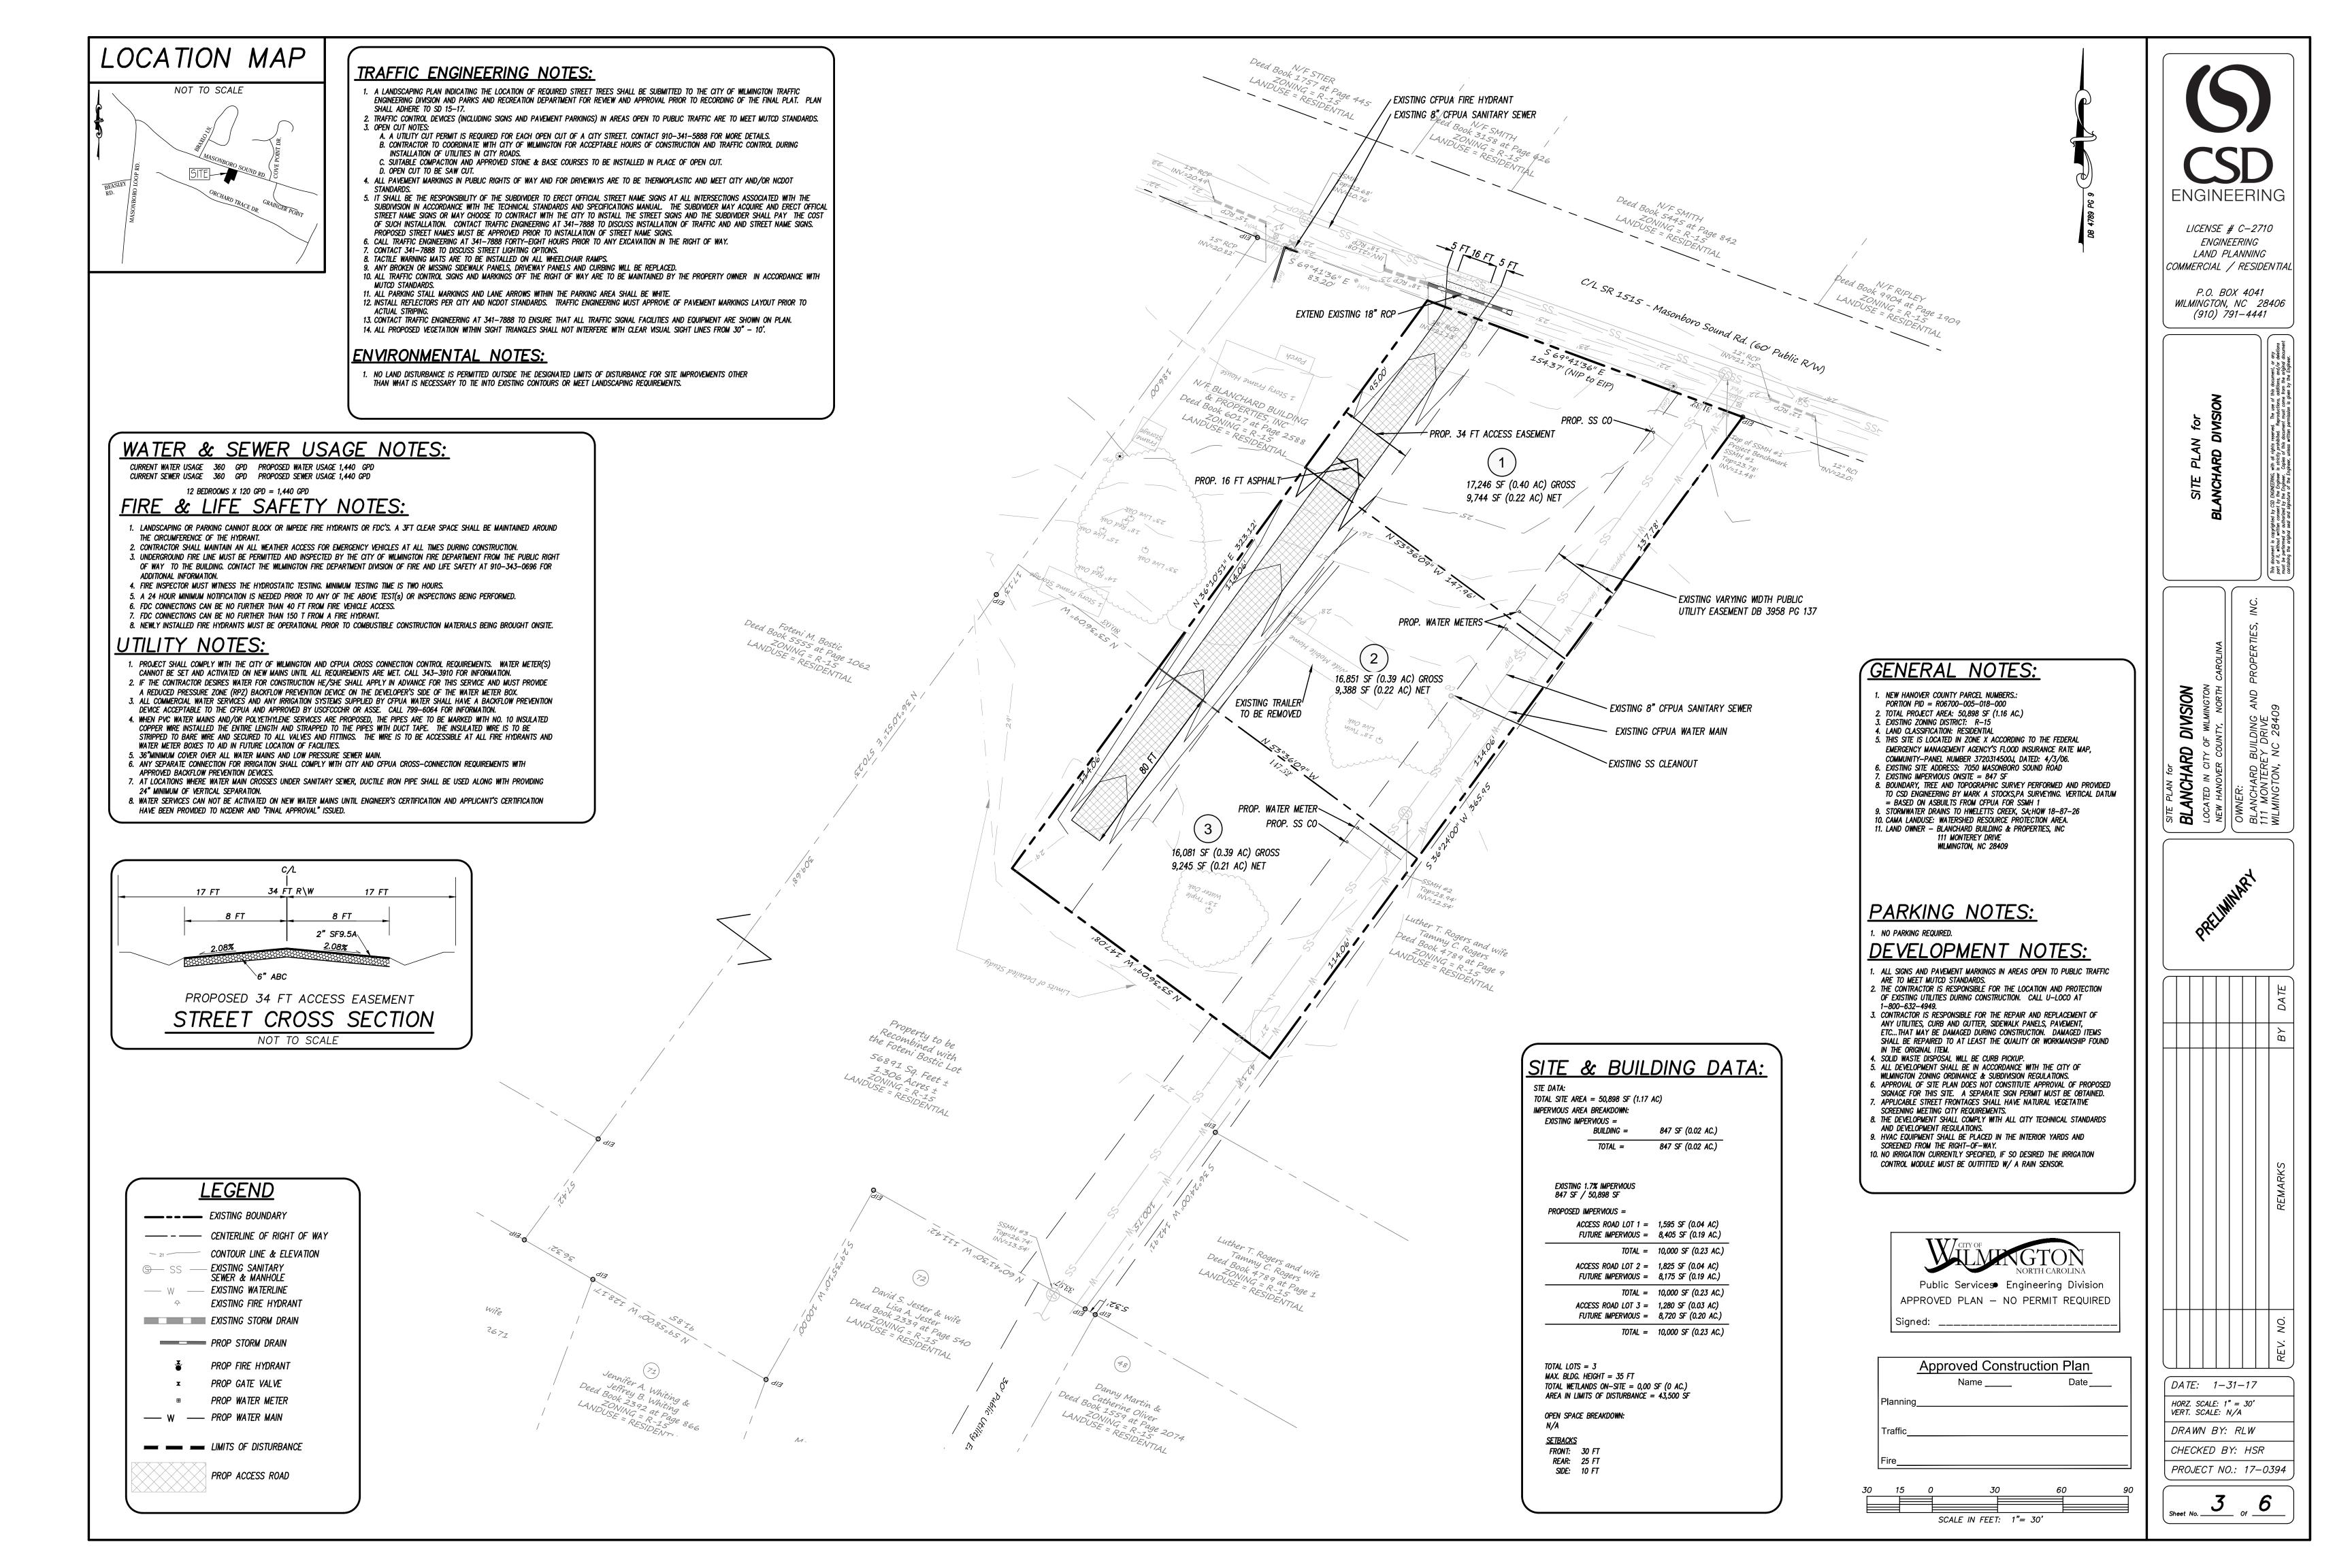


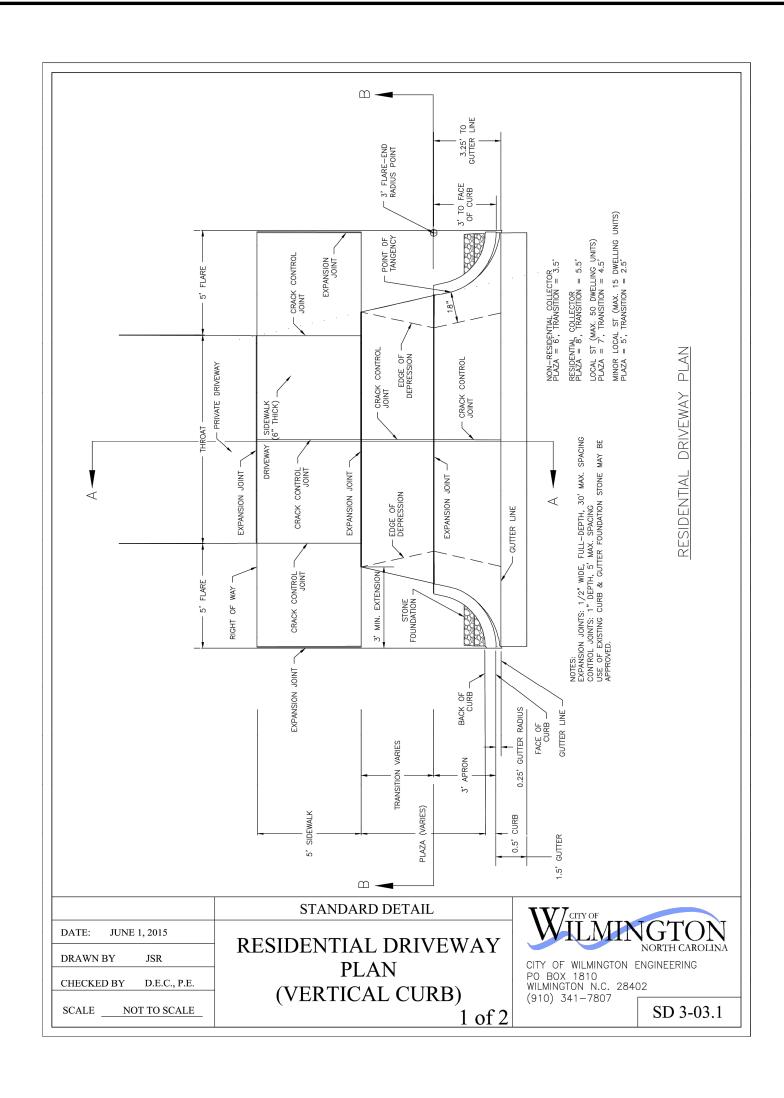


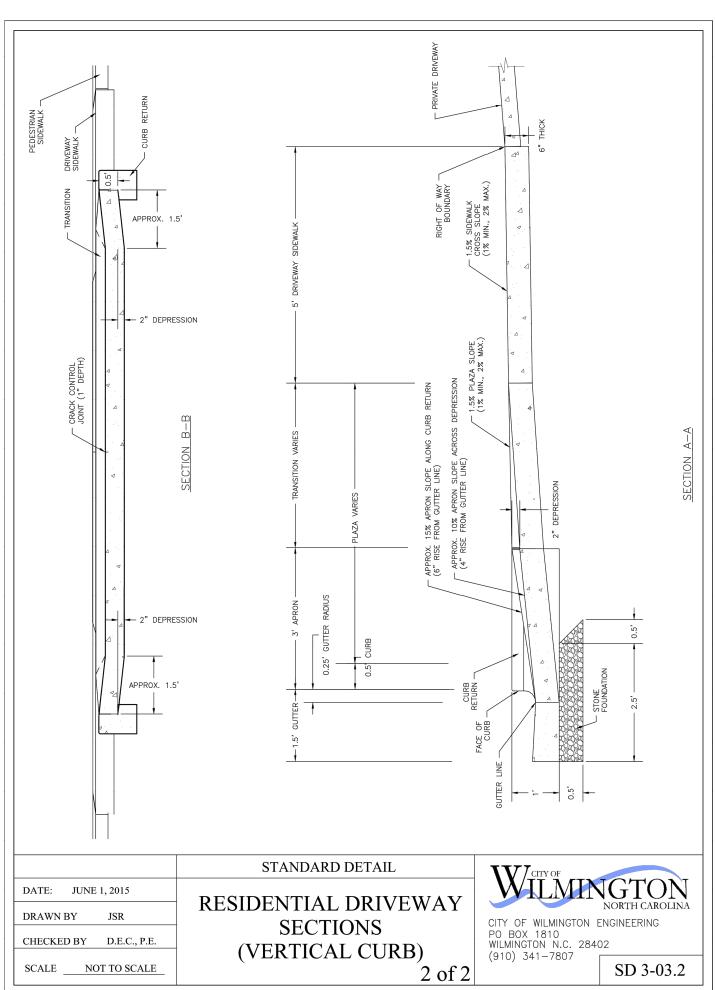


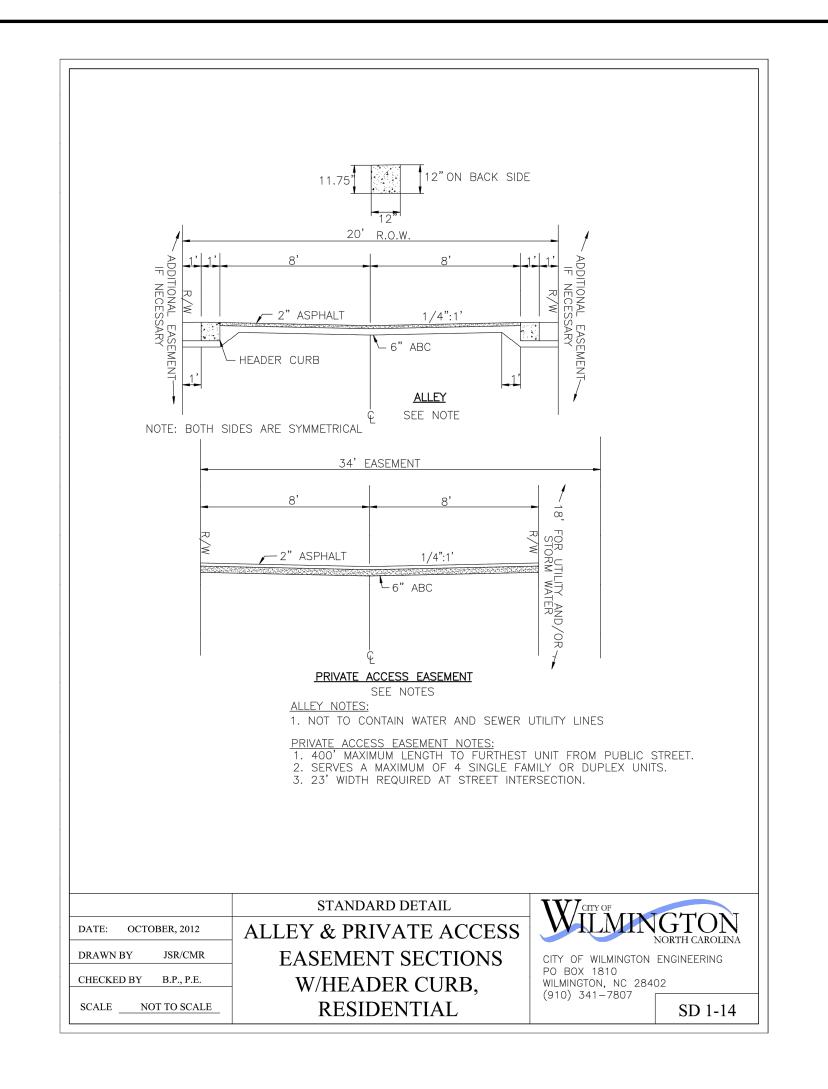

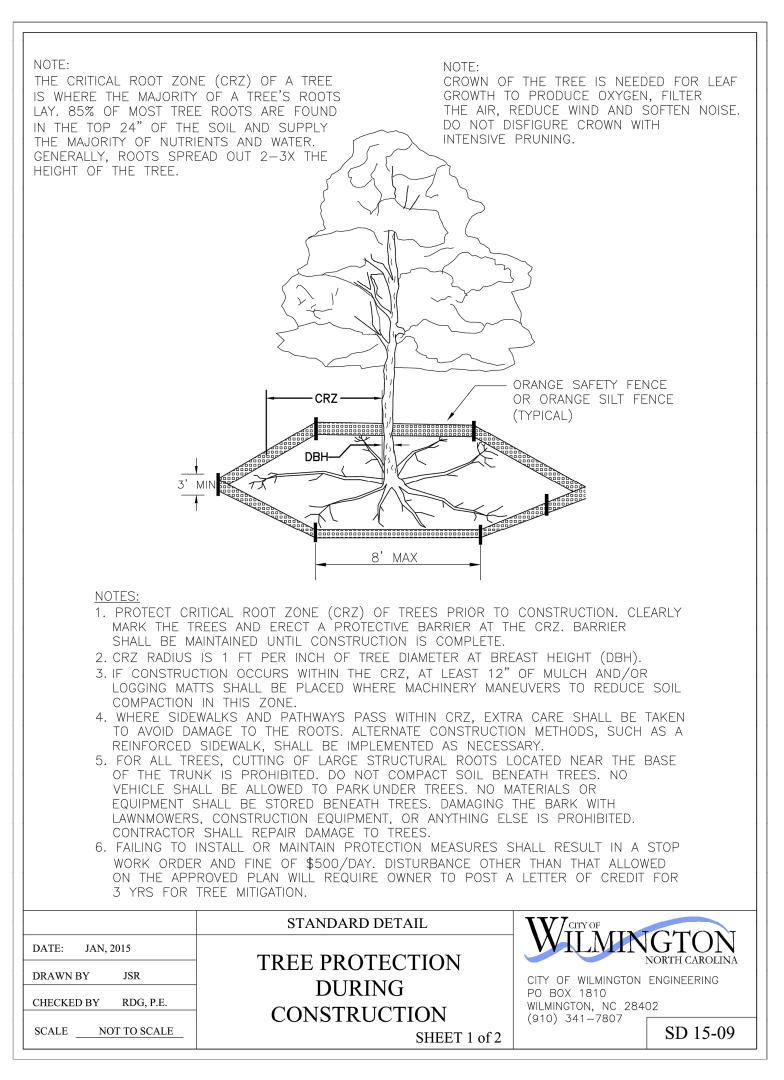

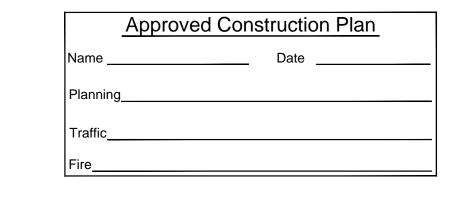


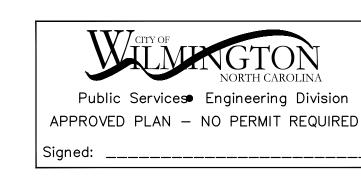


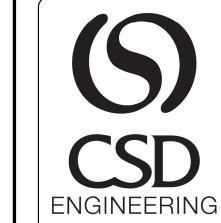

LICENSE # C-2710 ENGINEERING LAND PLANNING COMMERCIAL / RESIDENTIAL

P.O. BOX 4041 WILMINGTON, NC 28406 (910) 791–4441

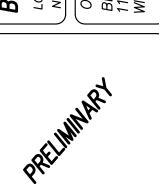

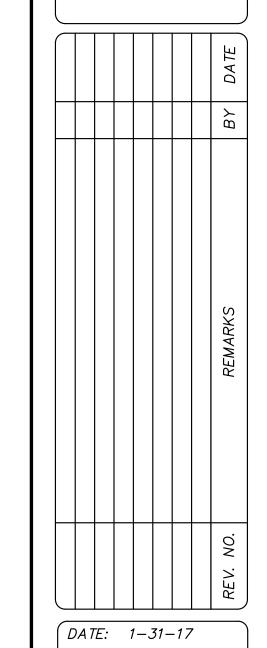


CITY OF WILMINGTON ENGINEERING PO BOX 1810 WILMINGTON, NC 28402 (910) 341-7807 SD 15-09 SHEET 2 of 2

PROJECT NO.: 17-0394

HORZ. SCALE: 1" = 30' VERT. SCALE: N/A

DRAWN BY: RLW

CHECKED BY: HSR

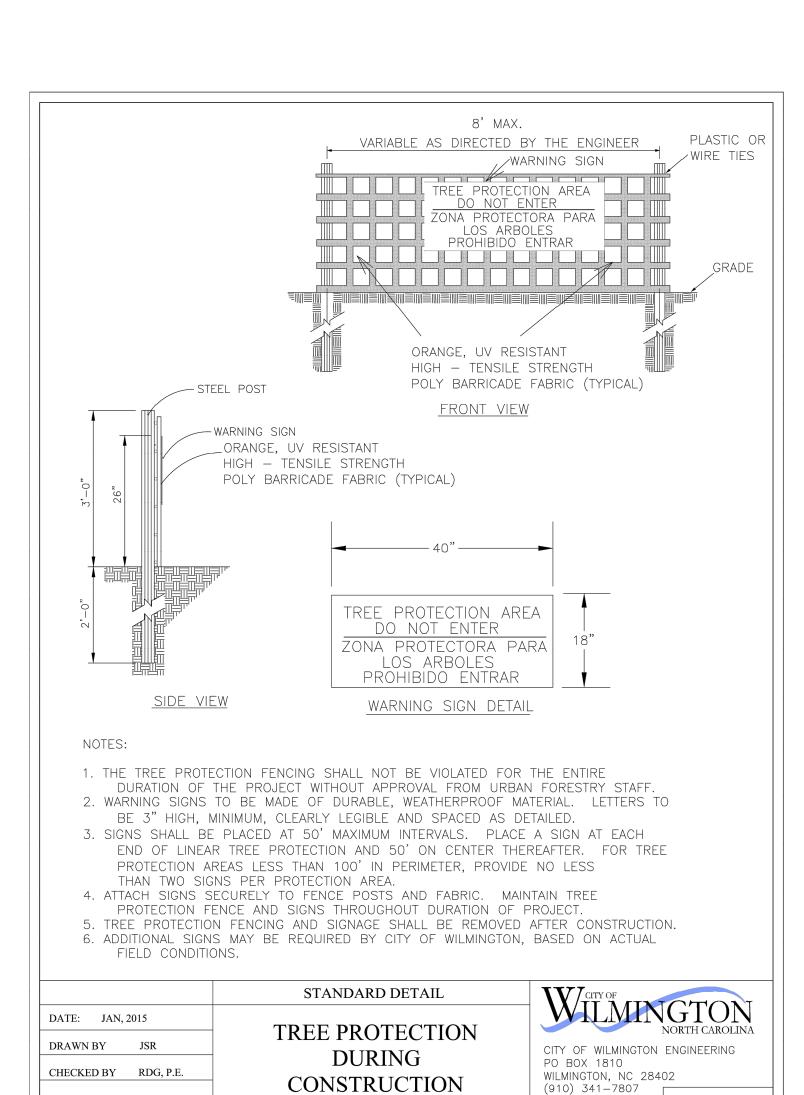

SCALE NOT TO SCALE